

SITE AREA	3,804.65m ²
EXISTING FLOOR AREA	170.60m ²
PROPOSED BUILD AREA	147.00m ²

SITE AREA	3,804.65m ²
-----------	------------------------

EXISTING FLOOR AREA

 170.60 m^2

PROPOSED BUILD AREA

147.00m²

COPYRIGHT STATEMENT

This plan always remains the copyright of designer & shall not be used other than for the project work intended without written authority. No part may be produced by any other exclusive right be exercised without permission legal enforcement will be taken on copyright infringement.

DISCLAIMER

This is not an official document, and may not comply with current laws or industry standards. You should make your own enquiries and seek independent advice from relevant industry professionals before acting or relying on the contents of this document.

ALL DIMENSIONS ARE IN METRES. DO NOT SCALE FROM PLANS

DATE	DESCRIPTION	REV	USER	CLIENT NAME	SHEET NAME	JOB NO:
09/08/2021	Site Plan Generated	1	L.S	PROPERTY DETAILS 7 North St, Greentell, NSW 2810, Australia Lot/DP: 7/28/DP758473	Site Plan	127971
					DESIGN NAME: HUTSON	SHEET NO: 1
					SCALE: 1:500 @A3	REV NO: 1
						DATE: 09/08/2021




COPYRIGHT STATEMENT

This plan always remains the copyright of designer & shall not be used other than for the project work intended without written authority. No part may be produced by any other exclusive right be exercised without permission legal enforcement will be taken on copyright infringement.

DISCLAIMER

This is not an official document, and may not comply with current laws or industry standards. You should make your own enquiries and seek independent advice from relevant industry professionals before acting or relying on the contents of this document.

ALL DIMENSIONS ARE IN METRES. DO NOT SCALE FROM PLANS.

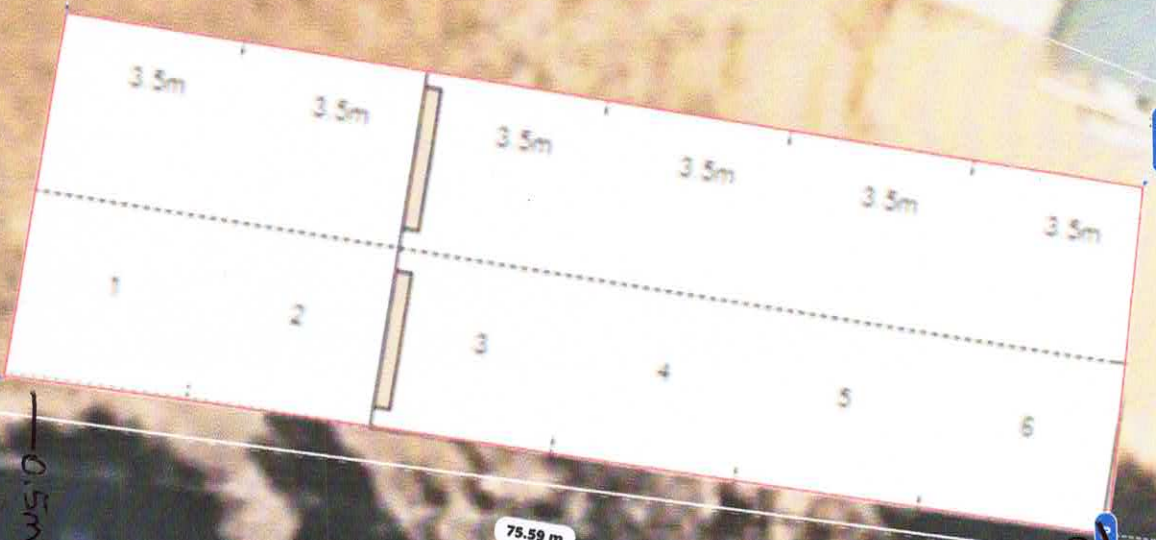

DATE

DESCRIPTION

REV

USER

CLIENT NAME

SHEET NAME

JOB NO:

09/08/2021

Site Plan Generated

1

L.S

PROPERTY DETAILS

7 North St, Grenfell, NSW
2810, Australia

Lot/DP: 7/28/DP758473

DESIGN NAME:

HUTSON

SHEET NO:

2

SCALE:

1:100 @ A3

REV NO:

1

DATE:

09/08/2021